ELECTRICAL / MECHANICAL / PLUMBING NOTES

PROVIDE ELECTRICAL SYSTEM GROUNDING PER SECTION 250 OF THE CALIFORNIA ELECTRICAL CODE TYPICAL.

SMOKE DETECTORS IN DWELLING UNITS SHALL BE HARDWIRED AND MOUNTED ON THE CEILING OR WALL AT A POINT CENTRALLY LOCATED IN THE CORRIDOR OR AREA GIVING ACCESS TO EACH SEPARATE SLEEPING AREA. IF THE DWELLING UNIT HAS MORE THAN ONE STORY A DETECTOR SHALL BE INSTALLED ON EACH STORY AND IN ANY BASEMENT IF APPLICABLE. WHEN SLEEPING ROOMS ARE ON AN UPPER LEVEL, A DETECTOR SHALL BE PLACED AT THE CEILING OF THE UPPER LEVEL IN CLOSE PROXIMITY TO THE STAIRWAY. DETECTORS SHALL SOUND AN AUDIBLE ALARM IN ALL SLEEPING AREAS OF THE DWELLING UNIT IN WHICH THEY ARE LOCATED. REFER TO C.E.C.

IN EVERY HABITABLE ROOM, RECEPTACLE OUTLETS SHALL BE INSTALLED SO THAT NO POINT ALONG THE FLOOR LINE IN ANY WALL SPACE IS MORE THAN SIX FEET MEASURED HORIZONTALLY, FROM AN OUTLET IN THAT SPACE. INCLUDING ANY WALL SPACE TWO FEET OR MORE IN WIDTH AND THE WALL SPACE OCCUPIED BY FIXED PANELS IN EXTERIOR WALLS, BUT EXCLUDING SLIDING PANELS IN EXTERIOR WALLS. THE WALL SPACE AFFORDED BY FIXED ROOM DIVIDERS, SUCH AS FREE-STANDING BAR-TYPE COUNTERS, SHALL BE INCLUDED IN THE SIX FOOT MEASUREMENT. C.E.C.

ATTICS AND ROOF AREAS THAT ARE ACCESSIBLE, THE ELECTRICAL CABLE WITHIN SEVEN (7) FEET OF OPENING SHALL BE PROCTECTED.PER C.E.C. 320.23

CARBON MONOXIDE ALARMS

(A) SPECIFY THAT CARBON MONOXIDE ALARMS SHALL BE INSTALLED IN THIS DWELLING PER C.R.C

(B) SPECIFY THAT CARBON MONOXIDE ALARMS SHALL BE "LISTED" AS COMPLYING WITH UL2034 AND UL2075 PER C.R.C. R315.3

(A) NOT BE OVER 6' FROM OPENINGS INCLUDING ANY WALL SPACE 2' OR WIDER.

(B) NOT BE MORE THAN 12' O.C. INCLUDING SLIDING GLASS DOORS.

(C) BE G.F.I. CIRCUTS WHEN INSTALLED WITHIN 6' OF SINKS AND WHEN INSTALLED OUTDOORS PER C.E.C. ARTICLE 210-8(a).

(D) HAVE WATERPROOF COVERS WHEN INSTALLED OUTDOORS.

A 22" x 30" MINIMUM ACCESS TO FURNACE

LOCATED IN THE ATTIC IS REQUIRED. IN ADDITION THE OPENING AND PASSAGEWAY MUST BE AS LARGE AS THE LARGEST COMPONENT OF THE APPLIANCE.

A SOLID 24" MIN. WIDE PLATFORM PATH FROM THE ACCESS OPENING TO THE FURNACE, WITH A RECEPTACLE AT THE FAU AND LIGHT, SWITCHED FROM THE ACCESS OPENING. PER C.M.C. 904.11

PROVIDE AN ADDITIONAL WATERTIGHT CORROSION RESISTANT METAL PAN BELOW CONDENSATE PRODUCING EQUIPMENT (IE. FURNACE) INSTALLED IN ATTIC. A SECONDARY DRAIN LINE MUST BE LOCATED AT A POINT WHERE IT CAN BE READILY OBSERVED. PER C.M.C. 310.2

ACCESS DOOR TO THE FURNACE/COOLING EQUIPMENT / COMPARTMENT SHALL BE A MINIMUM OF 24" WIDE AND A MINIMUM OF 30" CLEAR WORKING SPACE (OF A HEIGHT EQUAL TO THAT OF THE EQUIPMENT OR 6.5 FEET) ON THE FIREBOX SIDE.

PLUMBING FIXTURES (WATER CLOSETS AND URINALS) AND FITTINGS (FAUCETS AND SHOWERHEADS) INSTALLED IN RESIDENTIAL BUILDINGS SHALL COMPLY WITH THE PRESCRIPTIVE REQUIREMENTS OF CGBC SECTION 4.303.1.1 THROUGH 4.303.1.4.4

PLUMBING FIXTURES AND FITTINGS REQUIRED IN CGBC SECTION 4.303.1 SHALL BE INSTALLED IN ACCORDANCE WITH THE C.P.C AND SHALL MEET THE APPLICABLE REFERENCD STANDARDS.

ANNULAR SPACES AROUND PIPES, ELECTRIC CABLES, CONDUITS OR OPENINGS IN PLATES AT EXTERIOR WALLS SHALL BE PROTECTED AGAINST THE PASSAGE OR RODENTS BY CLOSING SUCH OPENINGS WITH CEMENT MORTAR, CONCRETE MASONRY OR SIMILAR METHOD ACCEPTABLE TO THE ENFORCING AGENCY.

HVAC SYSYTEM INSTALLERS ARE TRAINED AND CERTIFED IN THE PROPER INSTALLATION OF HVAC SYSTEMS.

SMOKE DETECTORS SHALL BE INTERCONNECTED 110V WITH BATTERY BACKUP, WHICH ARE AUDIBLE IN ALL SLEEPING AREAS AT THE FOLLOWING LOCATIONS:

(1) ALL BEDROOMS; (2) HALLWAYS LEADING TO BEDROOMS, (4) AT LEAST ONE AT EVERY LEVEL AND (5) FARTHER THAN 3 FEET HORIZONTAL DISTANCE FROM THE BATHROOM DOOR CONTAINING A BATHTUB OR SHOWER. PER C.R.C. R314.3, R314.4, R314.5.

AN ARC-FAULT CIRCUIT INTERRUPTER SHALL PROTECT ALL 120-VOLT, SINGLE PHASE, 15-AND 20-AMP BRANCH CIRCUITS SUPPLYING OUTLETS IN DWELLING UNIT FAMILY ROOMS, DINING ROOMS, LIVING ROOMS, PARLORS, LIBRARIES, DENS, BEDROOMS, SUNROOMS, RECREATION ROOMS, CLOSETS, HALLWAYS, OR SIMILAR ROOMS OR AREAS. PER C.E.C. 210.12(A)

TWO SMALL APPLIANCE BRANCH CIRCUITS ARE REQUIRED FOR THE KITCHEN AND ARE LIMITED TO SUPPLYING WALL AND COUNTER SPACE OUTLETS FOR THE KITCHEN, PANTRY, BREAKFAST ROOM, DINING ROOM, OR SIMILAR AREAS. NOTE: THESE CIRCUITS CANNOT SERVE OUTSIDE PLUGS, RANGE HOOD, DISPOSALS, DISHWASHERS OR MICROWAVES — ONLY THE REQUIRED COUNTERTOP/WALL OUTLETS INCLUDING THE REFRIGERATOR. PER C.E.C. 210-11(C)(1) AND 210-52 (B)

A DEDICATED 20-AMP CIRCUIT IS REQUIRED TO SERVE THE REQUIRED BATHROOM OUTLETS. THIS CIRCUIT CANNOT SUPPLY ANY OTHER RECEPTACLES, LIGHTS, FANS, ETC. (EXCEPTION-WHERE THE CIRCUIT SUPPLIES A SINGLE BATHROOM, OUTLETS FOR OTHER EQUIPMENT WITHIN THE SAME BATHROOM SHALL BE PERMITTED TO BE SUPPLIED.)

PER C.E.C. 210.52 (C)(3) AND EXCEPTION: CEC210.23(A)(1) AND (A)(2).


A DEDICATED 20-AMP BRANCH CIRCUIT SHALL BE PROVIDED TO SUPPLY THE LAUNDRY RECEPTACLE

PER C.E.C. 210.11(C)(2) AND 210.52(F)

A PRESSURE ABSORBING DEVICE (OR APPROVED MECHANICAL DEVICE), LOCATED AS CLOSE AS POSSIBLE TO QUICK ACTING VALVES, THAT WILL ABSORB HIGH PRESSURES RESULTING FROM THE QUICK CLOSING OF QUICK-ACTING VALVES (I.E., DISHWASHER, WASHING MACHINE, ETC.). PER C.P.C. 609.10

EXHAUST OUTLETS SHALL BE LOCATED A MINIMUM OF 10-FT FROM DOORS, OCCUPIED AREAS AND

PER C.M.C. 407.2.2

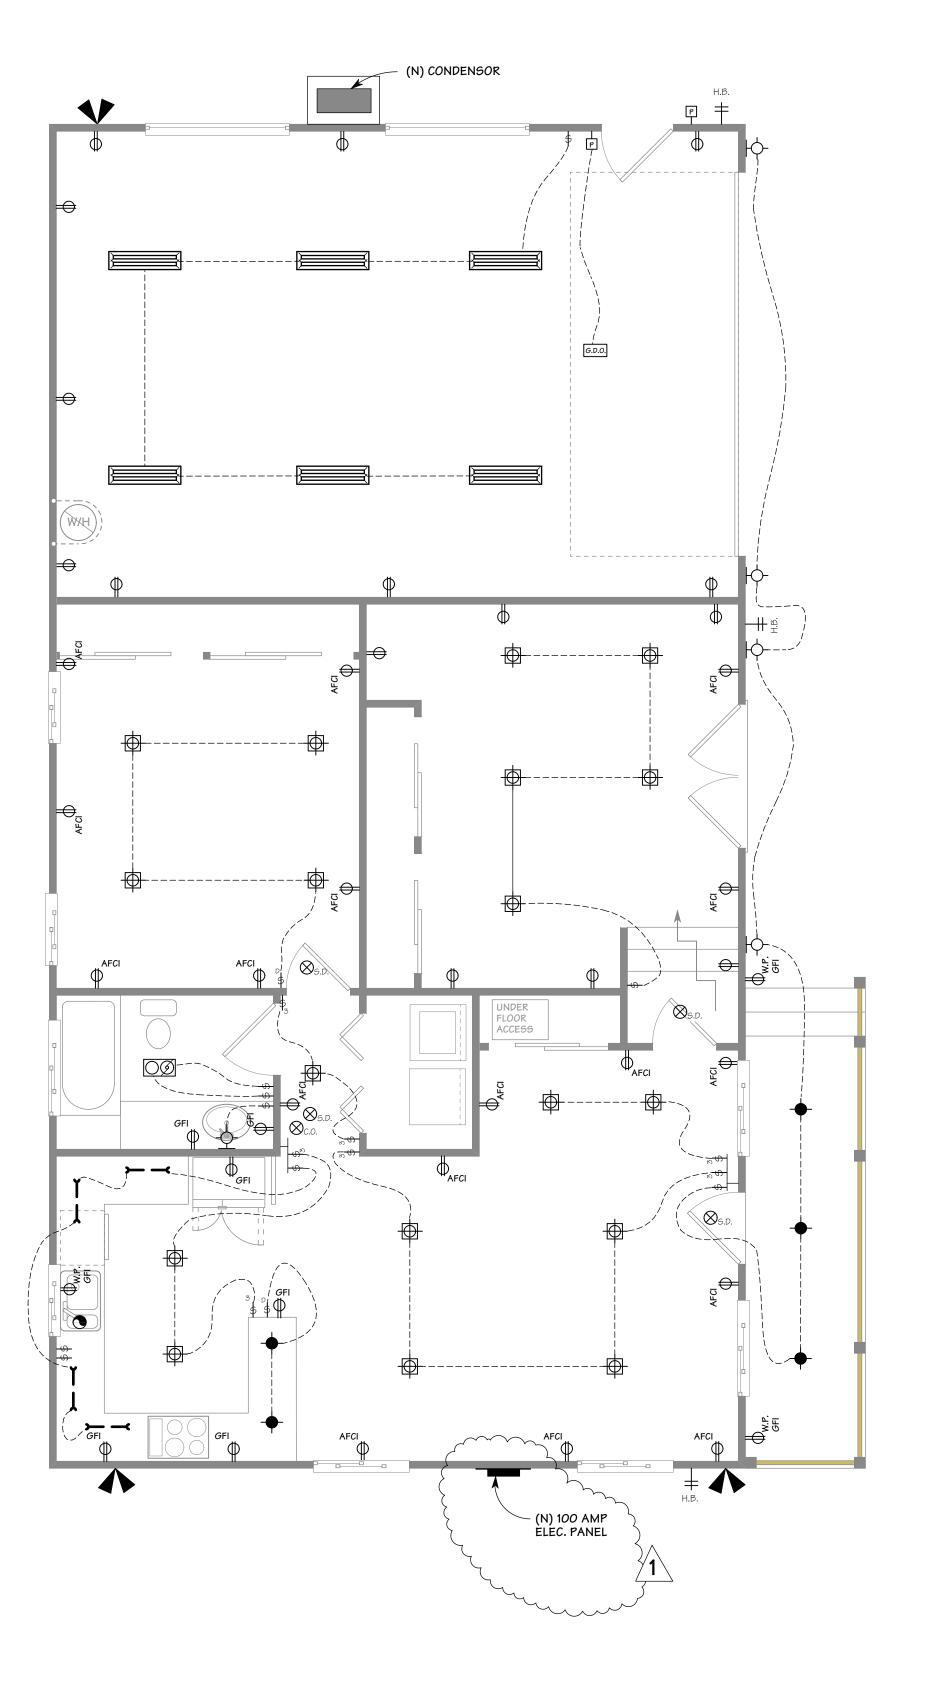

ELEC. / MECH. / PLUMB. PLAN

SCALE: 1/4" = 1'-0"

ELECTRICAL/MECHANICAL SYMBOL LEGEND

LIGHT SWITCH, SINGLE POLE; +48" U.O.N. LIGHT SWITCH, 3-WAY; +48" U.O.N. LIGHT SWITCH, DIMMABLE; +48" U.O.N. CEILING FAN/LIGHT CONTROL OUTLET, DUPLEX CONVENIENCE - 20A, 120V; +12" OUTLET, SAME AS ABOVE EXCEPT GFI TYPE OUTLET, SAME AS ABOVE EXCEPT GFI & WATER PROOF OUTLET, ARC-FAULT CIRCUIT INTERRUPTER OUTLET, IN CAB FACE, GFI IN KITCHEN SWITCHED OUTLET, 1/2 HOT - 20A, 120V; +12" U.O.N. OUTLET, FOURPLEX CONVENIENCE - 20A, 120V +12" U.O.N. OUTLET, INDIVIDUAL APPLIANCE - 20A, 220V UNDER-COUNTER OUTLET COUNTER-TOP OUTLET FLOOR OUTLET - 20A, 120V DOT ADJACENT TO SYMBOL INDICATES MOUNTING ABOVE COUNTER TOP PENDANT MOUNTED LIGHT FIXTURE SURFACE MOUNTED LIGHT FIXTURE LOW VOLTAGE RECESSED FIXTURE RECESSED CEILING LIGHT FIXTURE RECESSED FLOURESCENT CEILING LIGHT FIXTURE ACCENT LIGHT WALL MOUNTED LIGHT FIXTURE WALL SCONCE FLOURESCENT FIXTURE, UNDER CAB MNTD. DIRECT WIRE, LENGTH VARIES SURFACE MOUNTED FLUORESCENT FAN/FLUORESCENT LIGHT EXHAUST FAN (CEILING UNIT U.O.N.) (TO PROVIDE MIN. 5 AIR CHANGES/HR.

PER UBC 1203.3)

DISPOSAL

TELEPHONE OUTLET +12" U.O.N.

FLOOR MOUNTED TELEPHONE JACK

TELEVISION HOOKUP P PUSH BUTTON

DOORBELL CHIME THERMOSTAT

JUNCTION BOX

MOTOR CONNECTION $\langle \rangle$ APPROVED SMOKE DETECTOR - CEILING MOUNTED & WIRED TO MAIN SERVICE WITH BATTERY BACK-UP

APPROVED CARBON MONOXIDE DETECTOR -CEILING MOUNTED & WIRED TO MAIN SERVICE WITH BATTERY BACK-UP

G.D.O. GARAGE DOOR OPENER

GAS OUTLET F.G. KEY HOSE BIB w/ VACUUM BREAKER



AIR REGISTER AT FLOOR

AIR REGISTER @ CEIL.



AIR REGISTER @ WALL



MOTION / SOLOR FLOOD LIGHT



CEILING FAN

CHECKED BY PBD JOB NO. 18-23 DATE 11/23/2021

/ MECH.

ELEC. PLAN

DRAWN BY

Michael S. Radu

Miller & John

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AS SHOWN

SCALE

SHEET

A-5